
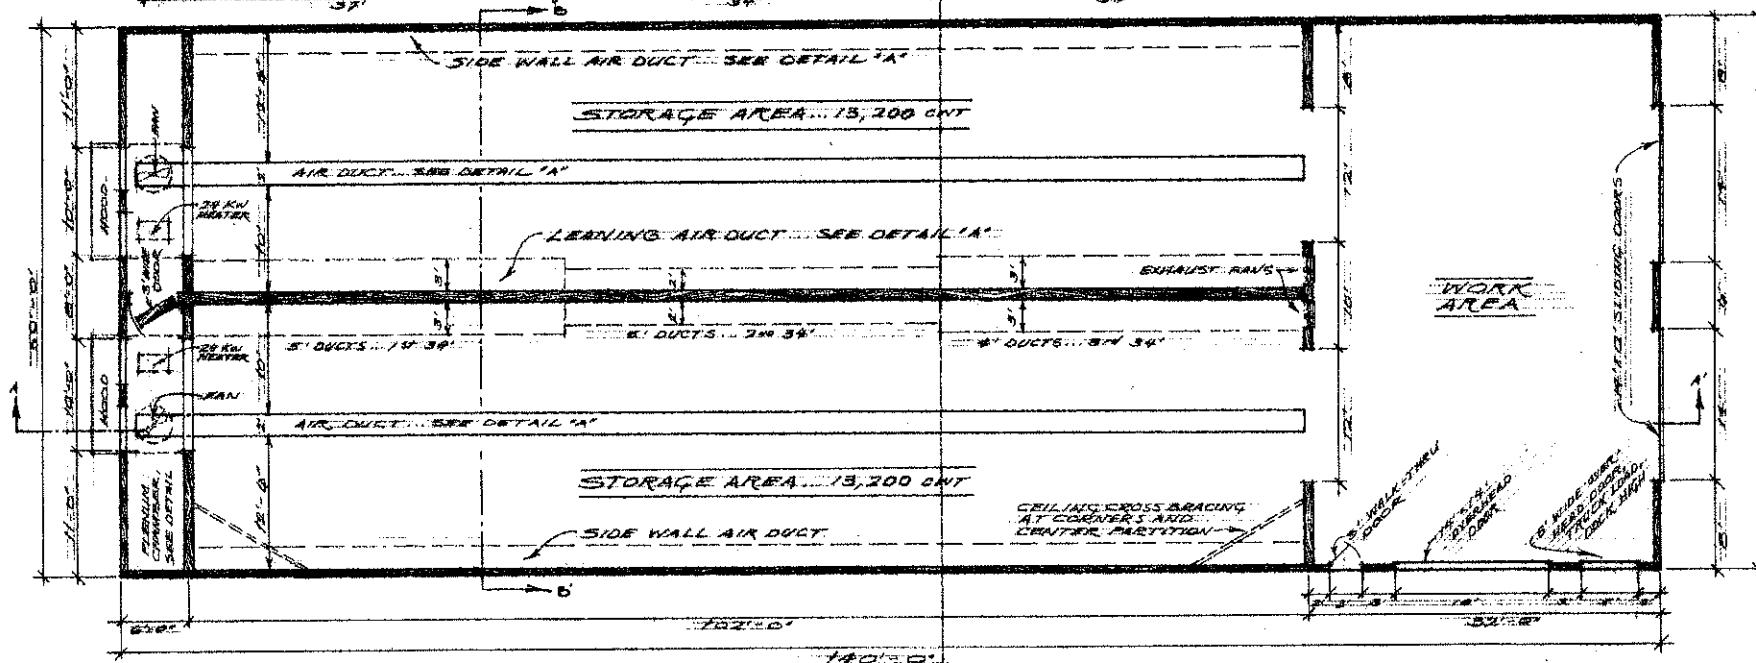
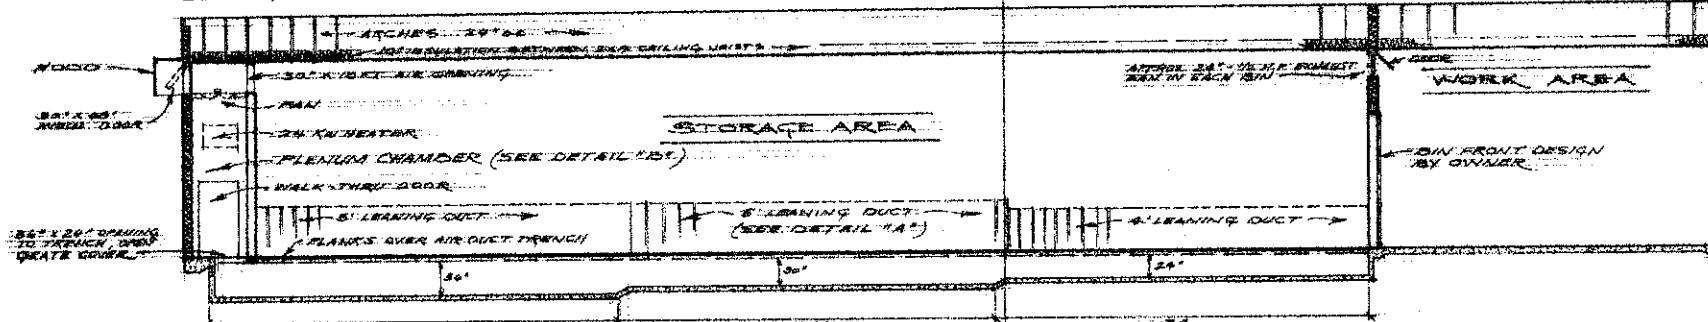


SECTION A-A'

SCALE: 1/8" = 1'-0"

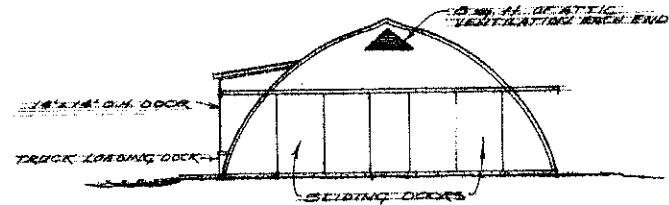

FLOOR PLAN

SCALE: 1/8" = 1'-0"

SECTION A-A'	SECTION A-A'	SECTION A-A'
SECTION A-A'	SECTION A-A'	SECTION A-A'
SECTION A-A'	SECTION A-A'	SECTION A-A'
SECTION A-A'	SECTION A-A'	SECTION A-A'



ND 134-6-13

SECTION A-A'	SECTION A-A'	SECTION A-A'
SECTION A-A'	SECTION A-A'	SECTION A-A'
SECTION A-A'	SECTION A-A'	SECTION A-A'
SECTION A-A'	SECTION A-A'	SECTION A-A'


SECTION A-A'

SECTION B-B'


SCALE: 1/4" = 1'-0"

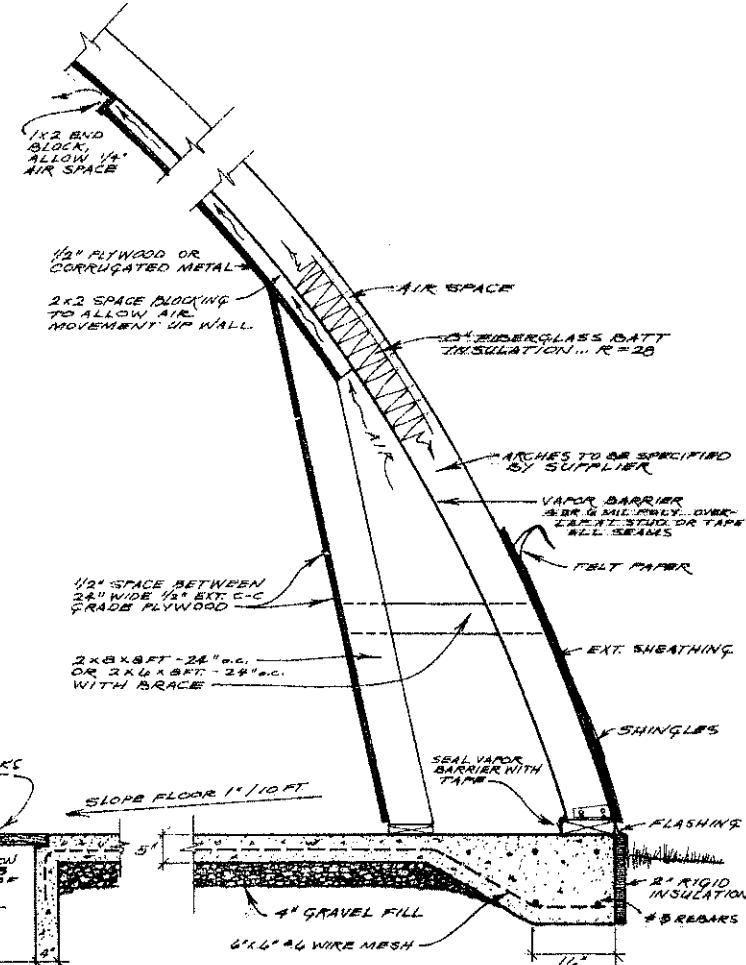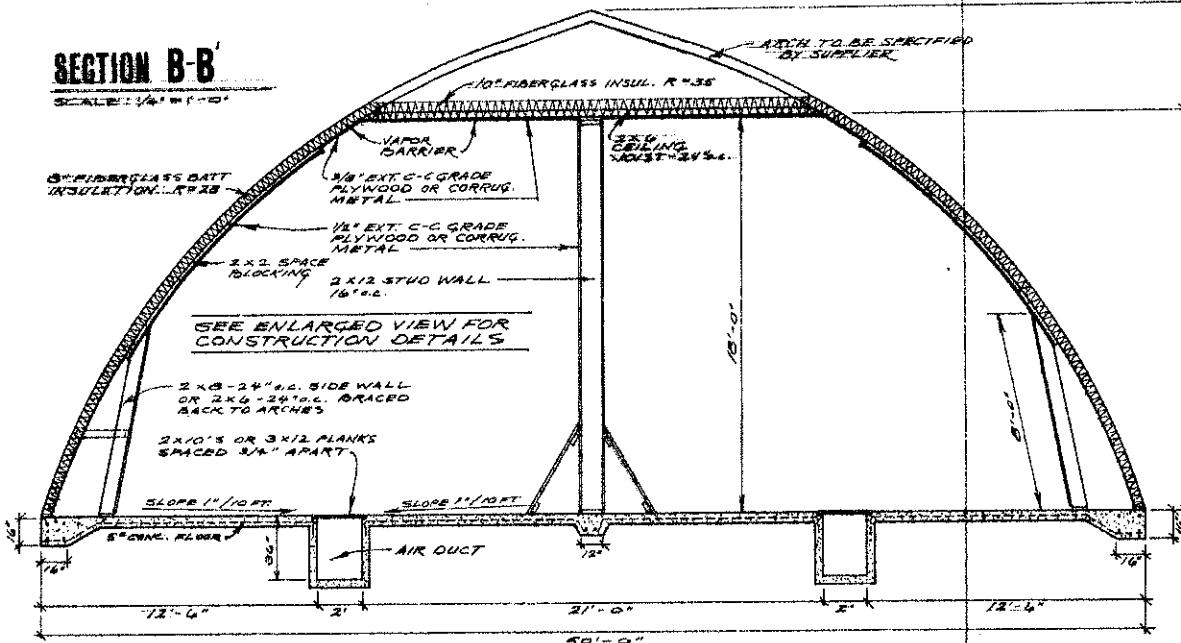

DETAIL A CONSTRUCTION DETAILS
SCALE: 1/4" = 1'-0"

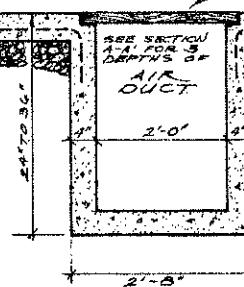

50' X 140'; 26,000 cu. ft. (WARM STORAGE) ARCHED ROOF POTATO STORAGE		SCALE	DRAWN BY
N.D. 734-6-13			P.L.G.C.
REVISED			
PREPARED BY			
NDSU Extension Agri. Engg. Dept.			
DATE	APPROVED BY	D. Lundstrom	DRAWING NUMBER
Feb '75			SCH 2003

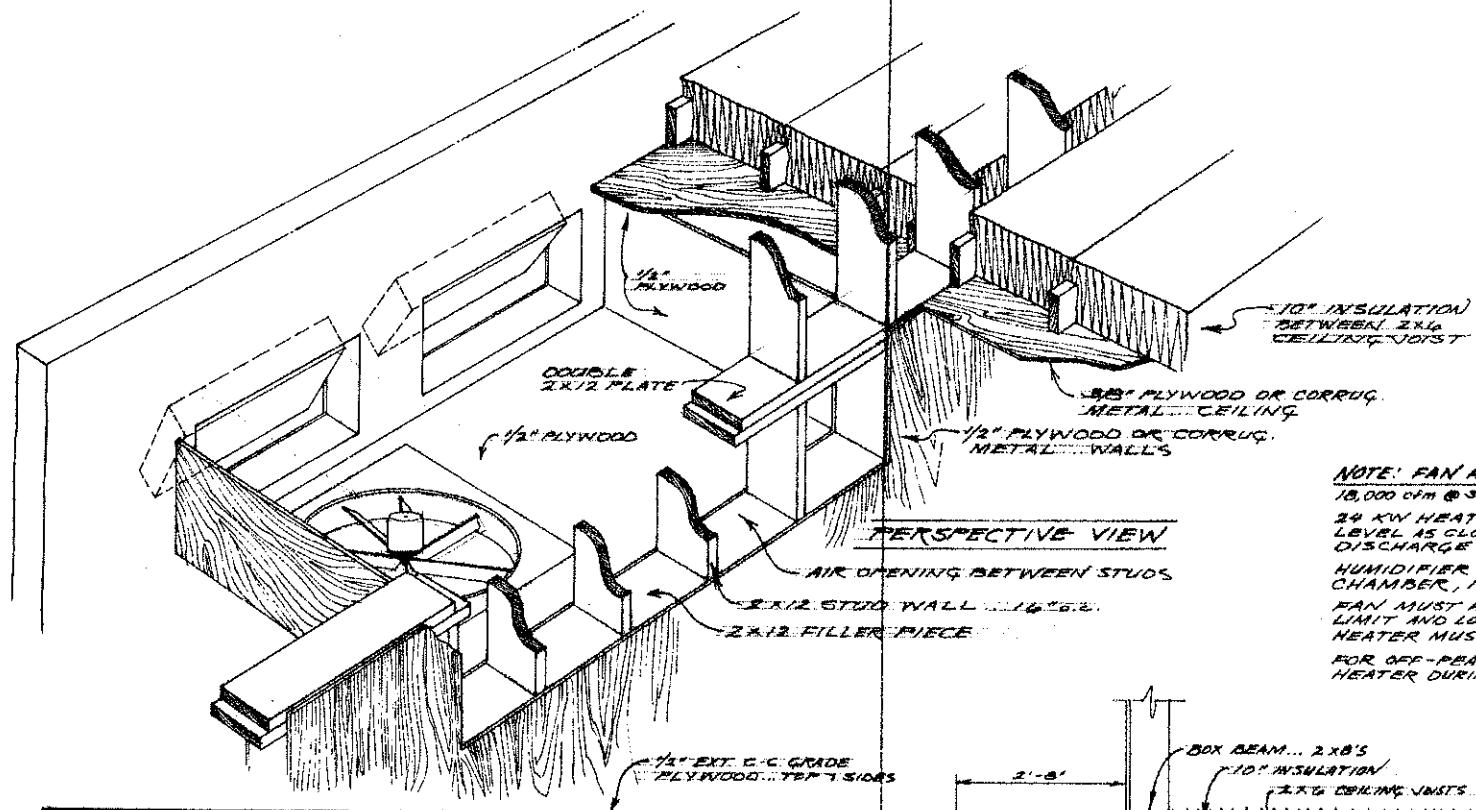


PERSPECTIVE VIEW


NOTE: FAN AND HEATER SPEC'S...

10,000 CFM @ 3/4" S.P. FAN, APPROX. 36" DIA., 5 H.P.
24 KW HEATER REQUIRED, MOUNT AT CEILING
LEVEL AS CLOSE TO FAN AS POSSIBLE WITH HEAT
DISCHARGE DIRECTLY INTO FAN BLAST.
HUMIDIFIER MAY BE INSTALLED IN PLENUM
CHAMBER, 12 GAL/HR RECOMMENDED OUTPUT.
FAN MUST HAVE ON-OFF CONTROLLER, HIGH-LIMIT
AND LOW-LIMIT THERMOSTATS. ELECTRIC
HEATER MUST HAVE THERMOSTAT CONTROL.

FOR OFF-PEAK POWER... FAN SHUTS OFF WITH
HEATER DURING OFF-TIME - HOWEVER, INSTALL
DOUBLE THROW-SWITCH SO FAN MAY BE RUN
CONTINUOUSLY IF NECESSARY.

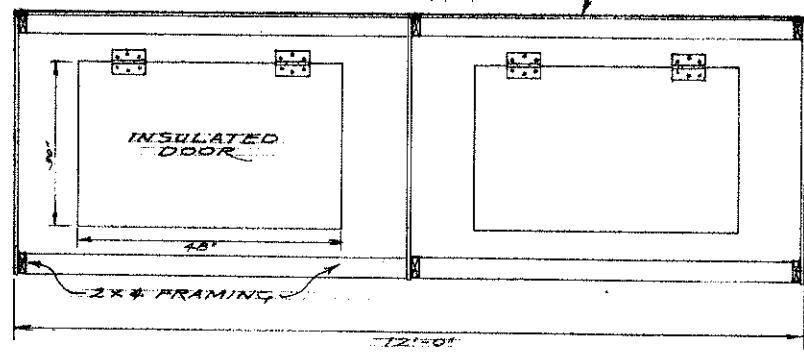

FRONT VIEW THRU HODD

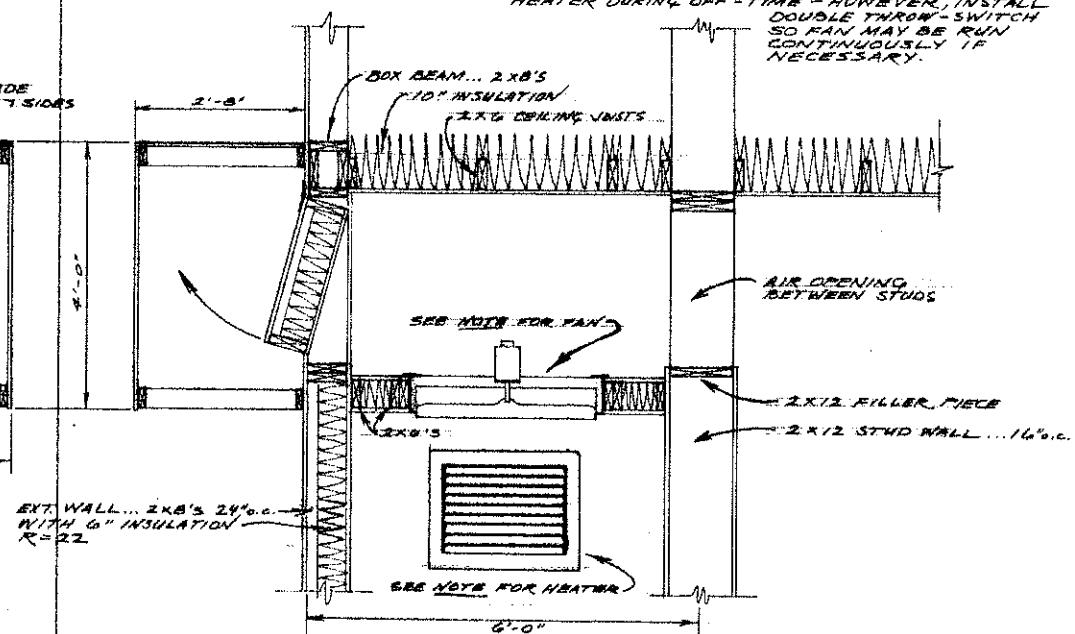

SECTION VIEW THRU HODD YARD

DETAIL B PLENUM CHAMBER, FAN, HEATER CONSTRUCTION DETAILS
SCALE: 1/4" = 1'-0"

ROTATED 360 DEG. (HARM. STORAGE) ARCHED ROOF POTATO STORAGE		ND. 734-6-13	SCALE	DRAWN BY R. COSSLETT REVISED
PREPARED BY NDSU Extension Agr. Engr. Dept.				
DATE Feb. 25	APPROVED BY D. Landstrum	DRAWN NUMBER 101		